NOTE:

IT IS BUILDER RESPONSIBILITY TO ESTABLISH THE FINISHED FLOOR LEVELS & FINISHED WALL HEIGHTS IN RELATION TO THE RELEVANT GROUND LEVELS DURING SETOUT & BEFORE ANY EXCAVATION WORKS ARE UNDERTAKEN SO AS TO ENSURE THAT ALL DESIGN ASSUMPTIONS ARE FULLY REALIZE IN PRACTICE & COMPLY WITH THE RELEVANT BUILDING CODES & SITTING REQUIREMENTS.

NOTE

USUALLY A SECTIONAL DETAIL IS SHOWN, SHOWING THE DAMP PROOF COURSE TERMINATING BELOW THE INTERNAL FLOOR LEVEL, AND A MIN I OOMM ABOVE EXTERNAL SURFACE. ALSO THIS SECTION WOULD HAVE A NOTE STATING "SURFACE AROUND THE PERIMETER OF DWELLING TO BE GRADED AWAY AT 25MM OVER THE FIRST METRE". THIS SAVE A HEAP OF HEADACHES AT THE END OF THE JOB, WHERE THE WEEP HOLES DON'T HAVE ENOUGH CLEARING, AND THE SURFACE AROUND THE DWELLING HAS NO FALL.

NOTE:

PROVIDE WEEPHOLES @ 960mm MAX.
CENTERS WITH CONTINUOUS FLASHING WHERE
THE BRICKWORK EXTENDS OVER THE OPENING

NOTE:

WEEP HOLES @ 1.2 METRE SPACING AND ABOVE WINDOWS MORE THAN 1.0 METRE WIDE.

NOTE:


ROOF DESIGN SHOWN FOR GUIDE PURPOSES ONLY, SEE THE ROOF MANUFACTURES DRAWINGS FOR EXACT DESIGN.

NOTE:

WHERE CONSTRUCTION JOINTS ARE ADJACENT TO A DOOR OR OPENING, THE ARTICULATION JOINTS ARE TO EXTEND ALONGSIDE THE OPENING.


NOTE:

STEP DOWN NOT EXCEED 230mm FOR (L'DRY DOOR, REAR SLIDING DOOR & FRONT DOOR)

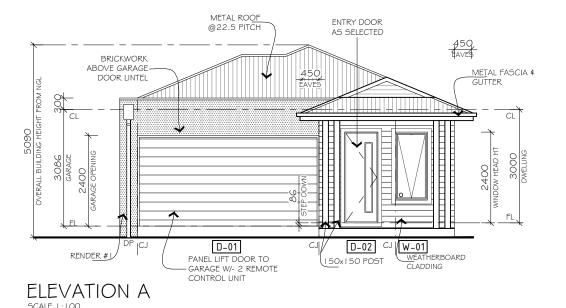

All lintel sizes to be checked and compared with engineer's specifications/size recommendations WINDOW NO HEIGHT WIDTH QTY. Aluminium frame awning 1800 850 window Aluminium frame sliding 2,3,11 1027 610 3 window (obscure safety glass) Aluminium frame sliding 4,5,6,12 4 1200 1810 window Aluminium frame sliding 7,8 1800 850 window Aluminium frame sliding 9 1800 1810 window Aluminium frame fixed 10 600 2170 window DOOR NO. HEIGHT WIDTH QTY. 2400 4800 Panel lift garage door 2 2340 820 Designer 820 entry door 3 2040 720 External 820 ½ glass door 4 2100 2238 Aluminium frame stacker door 2040 820 External 820 door Alternative timber lintels in NOTE: F27 seasoned hardwood as per AS 1684. All Glazing to comply with AS-1288-2006

WINDOW & DOOR SCHEDULE

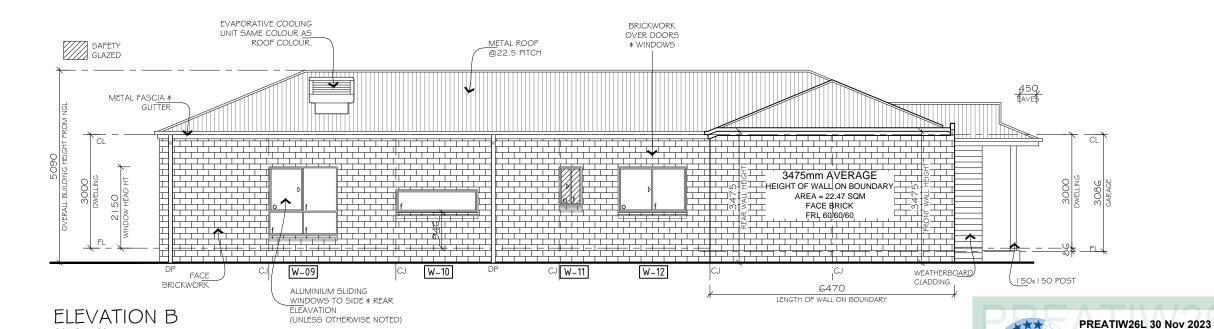

ELEVATIONS

WITH PART 10.4.2 OF THE NCC 2022 VOL 2

NOTES:
WRITTEN DIMENSIONS TAKE PRECEDENCE OVER SCALE. FLOOR
PLAN DIMENSIONS ARE TO FRAME SIZE ONLY.
WINDOW SIZES SHOWN ARE SUPPLIERS FRAME SIZES.
ALL GLAZING TO COMPLY WITH A.S. 1288-2021 & AS 2047-2014 GLASS
IN BUILDINGS, & WITH A.S. 4055-2012 FOR WINDLOADING.
WINDOW SUPPLIER TO PROVIDE COVER BOARDS TO ALL CORNER
WINDOWS U.N.O.
GARAGE ROOF TO BE TIED DOWN MIN. 1200 INTO BRICKWORK WITH
HOOP IRON STRAPS.
ALL WATER CLOSET DOORS TO BE REMOVABLE IN ACCORDANCE

JOB NUMBER: OOO I SHEET NUMBER ► SHEET CONTENT: SCALE: 1:100 4 of 7 () ELEVATIONS: A & B DATE: 28.10.23 DRAWN: PROPERTY ADDRESS: SSUE: DATE: DETAILS: NITIALS LOT 605 EAGLE ROAD, GH A 28.10.23 SKETCH ARMSTRONG CREEK 3217 B 30.10.23 SKETCH - REV GH BANK DRAWING GH CLIENT GH D 17.11.23 WORKING DRAWING VISHAL PANDIT GH E 29.11.23 WORKING DRAWING - REV WORKING DRAWING

6

HOUSE

137.9

Assessor

Address Lot 605 Eagle Road Armstrong Creek VIC 3217

Accreditation No.

Nicholas Verginis

DMN/19/1914

https://www.fr5.com.au/QRCodeLanding?PublicId=PRE